


# CAY HILLS

A PORTION OF GOVERNMENT LOT 2  
SECTION 19, T24N., R.5E., W.M.

N

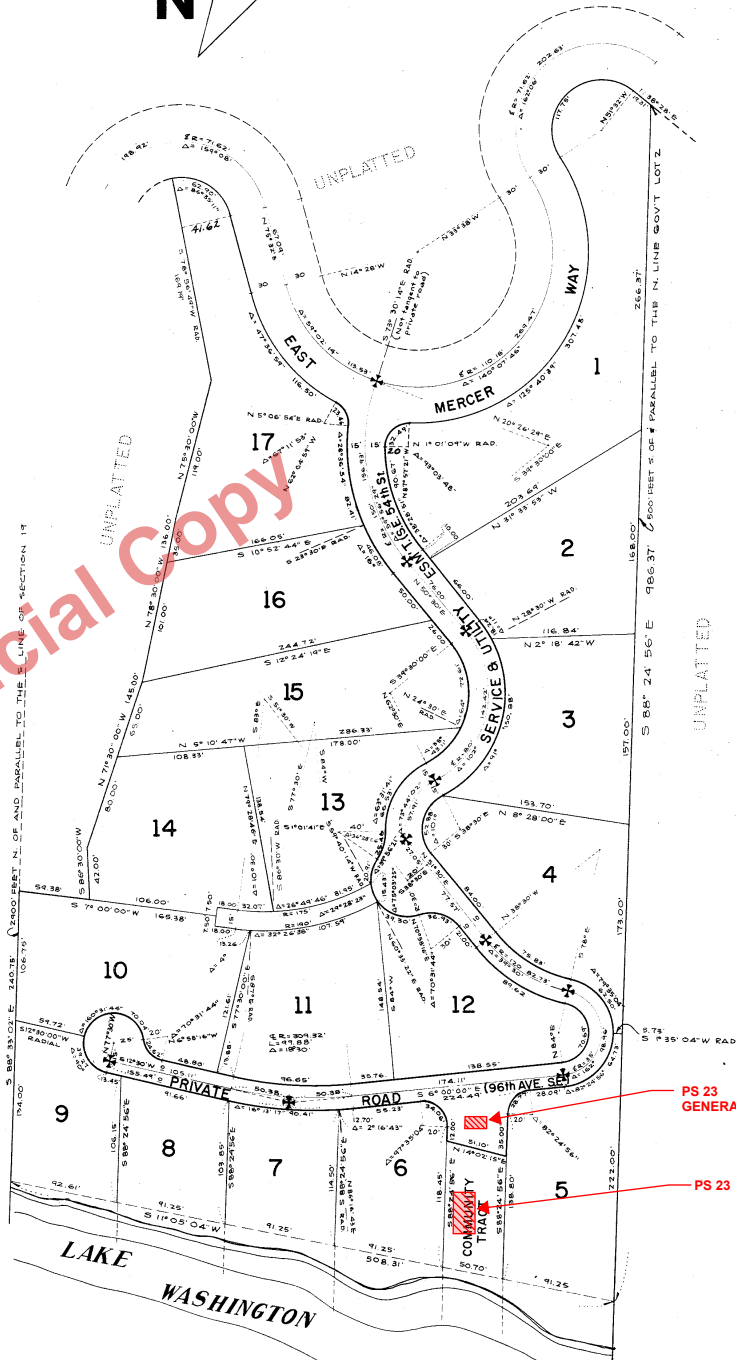

### DESCRIPTION

This plat of Cay Hills embraces that portion of Government Lot 2, Sec. 19, T24N, R5E, W.M. lying east of East Mercer Way except the north 500 feet thereof and except that portion thereof lying south of a line 2,900 feet north of and parallel to the south line of said Section 19, together with shorelands adjacent;


EXCEPT that portion thereof described as follows:  
Beginning at the intersection of the west line of said Government Lot 2 with a line 2,900 feet north of and parallel to the south line of said Section 19; thence S 88° 33' 02" E parallel to said south line 1328.34 feet to the true point of beginning; thence N 07° 00' 00" E 59.38 feet; thence S 86° 30' 00" W 42.00 feet; thence N 71° 30' 00" W 145.00 feet; thence N 78° 30' 00" W 136.00 feet; thence N 75° 30' 00" W 119.00 feet; thence S 78° 56' 49" W 169.19 feet to the easterly margin of East Mercer Way, thence southerly along said easterly margin to an intersection with a line 2,900 feet north of and parallel to the south line of said Sec. 19, thence S 88° 33' 02" E along said line to the true point of beginning.

### ENGINEER'S CERTIFICATE

I hereby certify that this plat of CAY HILLS is based upon an actual survey and subdivision of Section 19, T24N, R5E., W.M.; that the distances and courses are shown hereon correctly, that the monuments have been set and the lot and block corners staked correctly on the ground and that I have fully complied with the provisions of the statutes and the regulations governing platting.

*Robert W. Jones*  
Robert W. Jones

Certificate number 2534  
Renewal number 514-0130300  
Expiration date 1 January 1963

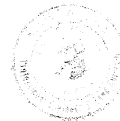

PS 23  
GENERATOR

PS 23

# CAY HILLS (CONTINUED)

SIGNATURES ILLEGIBLE DUE TO USE OF COLORED INKS

### DECLARATION

KNOW ALL MEN BY THESE PRESENTS that we the undersigned, owners in fee simple of the land hereby platted hereby declare this plat IN WITNESS WHEREOF we have set our hands and seals.

J. D. Florito	Vera S. Florito
Elmer A. DeTore	Mary Florito DeTore
Ernest Ferullo	Florence Florito Ferullo
Waldo Merlino	Gertrude Florito Merlino
David S. Cahill	Sally S. Cahill

### ACKNOWLEDGEMENTS

State of Washington }  
County of King } S.S.

THIS IS TO CERTIFY that on this \_\_\_\_\_ day of \_\_\_\_\_, A.D., 1962, before me the undersigned, a notary public, personally appeared J.D. Florito and Vera S. Florito, his wife, to me known to be the individuals who executed the within declaration and acknowledged to me that they signed and sealed the same as their voluntary act and deed for the use and purposes therein mentioned.

WITNESS my hand and official seal the day and year first written.



State of Washington }  
County of King } S.S.

THIS IS TO CERTIFY that on this \_\_\_\_\_ day of \_\_\_\_\_, A.D., 1962, before me the undersigned, a notary public, personally appeared Elmer A. DeTore and Mary Florito DeTore, his wife, to me known to be the individuals who executed the within declaration and acknowledged to me that they signed and sealed the same as their voluntary act and deed for the use and purposes therein mentioned.

WITNESS my hand and official seal the day and year first written.



State of Washington }  
County of King } S.S.

THIS IS TO CERTIFY that on this \_\_\_\_\_ day of \_\_\_\_\_, A.D., 1962, before me the undersigned, a notary public, personally appeared Ernest Ferullo and Florence Florito Ferullo, his wife, to me known to be the individuals who executed the within declaration and acknowledged to me that they signed and sealed the same as their voluntary act and deed for the use and purposes therein mentioned.

WITNESS my hand and official seal the day and year first written.



State of Washington }  
County of King } S.S.

THIS IS TO CERTIFY that on this \_\_\_\_\_ day of \_\_\_\_\_, A.D., 1962, before me the undersigned, a notary public, personally appeared Waldo Merlino and Gertrude Florito Merlino, his wife, to me known to be the individuals who executed the within declaration and acknowledged to me that they signed and sealed the same as their voluntary act and deed for the use and purposes therein mentioned.

WITNESS my hand and official seal the day and year first written.



State of Washington }  
County of King } S.S.

THIS IS TO CERTIFY that on this \_\_\_\_\_ day of \_\_\_\_\_, A.D., 1962, before me the undersigned, a notary public, personally appeared David S. Cahill and Sally S. Cahill, his wife, to me known to be the individuals who executed the within declaration and acknowledged to me that they signed and sealed the same as their voluntary act and deed for the use and purposes therein mentioned.

WITNESS my hand and official seal the day and year first written.

Notary public in and for the State of Washington residing at \_\_\_\_\_ My Commission expires \_\_\_\_\_

### APPROVALS

Examined and approved this \_\_\_\_\_ day of August, 1962 A.D., 1962

*Russell Q. David*  
City Engineer



I hereby certify that this plat complies with the conditions set forth by the Mercer Island Planning Commission and is duly approved this \_\_\_\_\_ day of August, A.D., 1962

*George N. Linn*  
Chairman

*Sally S. Cahill*  
Secretary

Approved by the Mercer Island City Council this \_\_\_\_\_ day of August, A.D., 1962.

*John J. ...*  
Mayor, City of Mercer Island

*John J. ...*  
Attest: City Clerk

I hereby certify that there are no delinquent special assessments and that all special assessments on any of the property hereon contained dedicated as streets, alleys or for other public use are paid in full this \_\_\_\_\_ day of August, A.D., 1962.

*Alton W. Lucas*  
City Clerk-Treasurer



### TREASURERS CERTIFICATE

I hereby certify that all property taxes are paid, that there are no delinquent special assessments certified to this office for collection and all special assessments on any property herein dedicated as streets, alleys or other public use are paid for in full this \_\_\_\_\_ day of August, A.D., 1962

*Alton W. Lucas*  
King County Treasurer

5473100



### RECORDING CERTIFICATE

Filed for the record at the request of the City of Mercer Island City Council this \_\_\_\_\_ day of August, A.D., 1962 at \_\_\_\_\_ minutes past 2:00 P.M. and recorded in Vol. \_\_\_\_\_ of Plats, page 595 96 Records of King County, Washington.

*Robert J. Morrisio*  
County Auditor

*William Williams*  
Deputy County Auditor

### RESTRICTIONS

No lot or portion of a lot in this plat shall be divided and sold or resold or ownership changed or transferred whereby the ownership of any portion of this plat shall be less than the area required for the use district in which located.

Lots 4, 10, 11, 12 and 13 shall each have an undivided one-fifth (1/5) interest in the Community Tract






- Legend**
- Sewer Pump Station
  - Address
  - Parcels
  - Buildings
  - Major Roads
  - Street Centerline
  - Parks
- March 2020
- Red: Band\_1
  - Green: Band\_2
  - Blue: Band\_3

- 8' Antenna
- 6' Electrical Equipment Pedestal
- 8' Support Pedestal w/ 12' Vent Pipes

1: 200

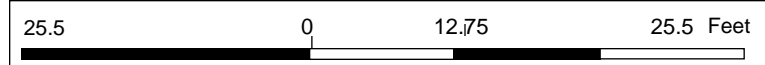


**Disclaimer:** These maps were developed by the City of Mercer Island and are intended to be a general purpose digital reference tool. These maps are not an accepted legal instrument for describing, establishing, recording or maintaining descriptions for property concerns or boundaries. The City makes no representation or warranty with respect to the accuracy or currency of these data sets, especially in regard to labeling of surveyed dimensions, or agreement with official sources such as records of survey, or mapped locations of features.

**Notes**

# Pump Station 23 Generator Photo Detail

## 5406 96th Ave SE

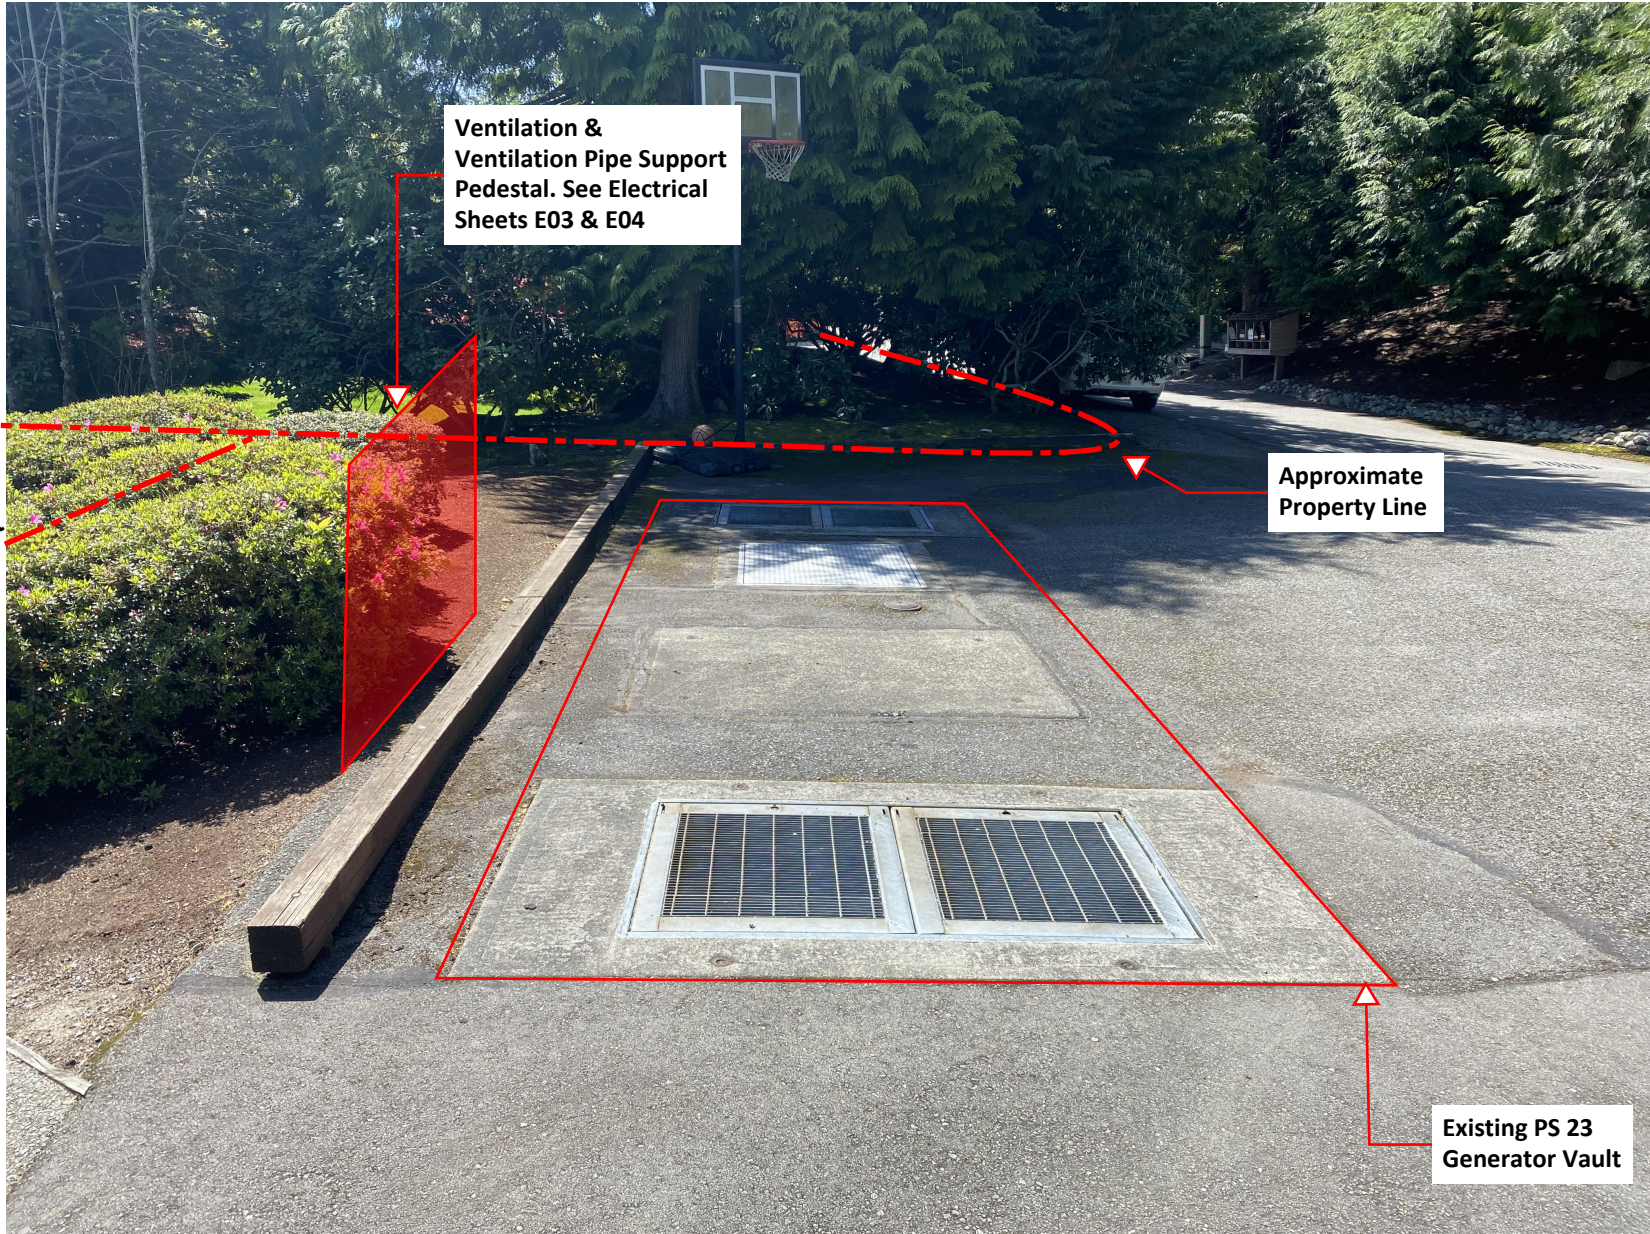


**Note: Property lines shown are approximate. Refer to Cay Hills Tract Map King County Plat Book 70 Pages 95-96**

9611 SE 36th Street, Mercer Island, WA 98040 / (206) 275-7600 / [www.mercerisland.gov](http://www.mercerisland.gov)




# Pump Station 23 Photo Detail

## 5406 96th Ave SE

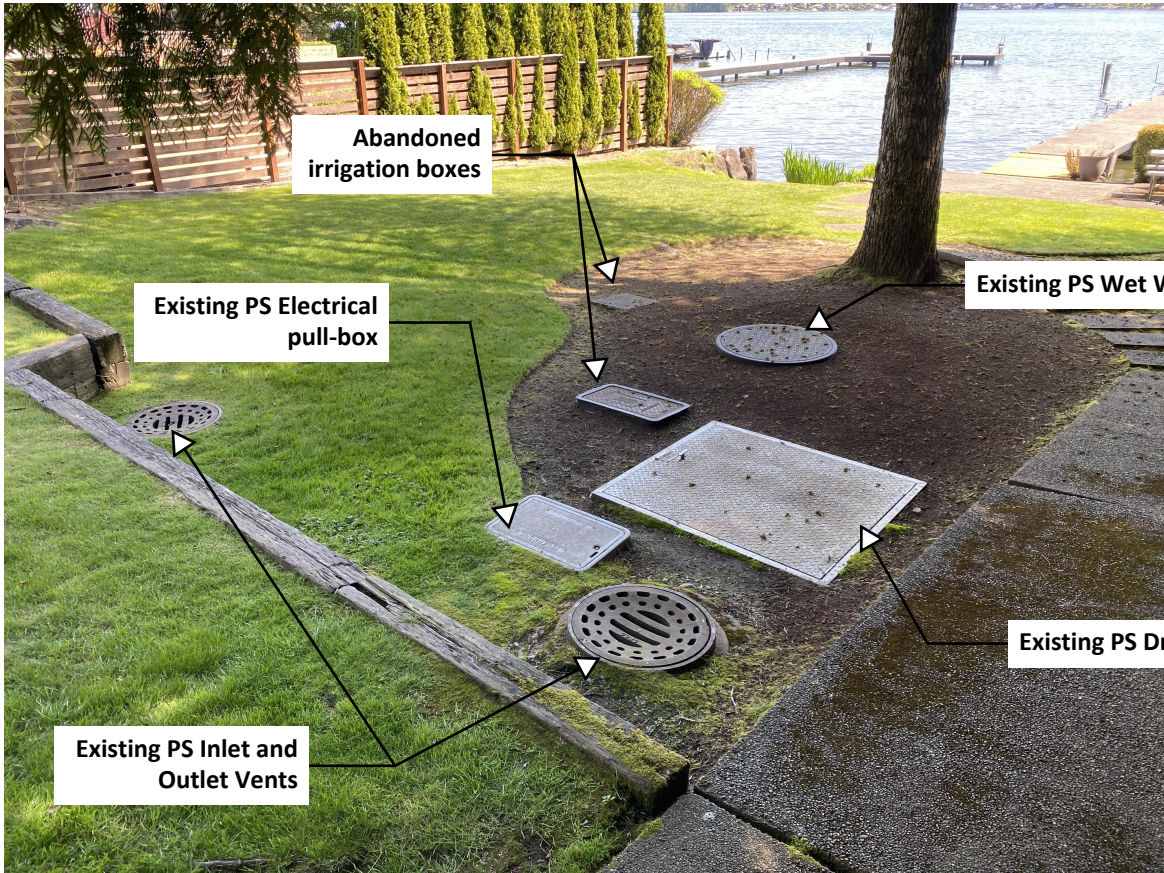


**Note: Location of Proposed 8' Antenna to be field determined. Max. 6' from PS.**




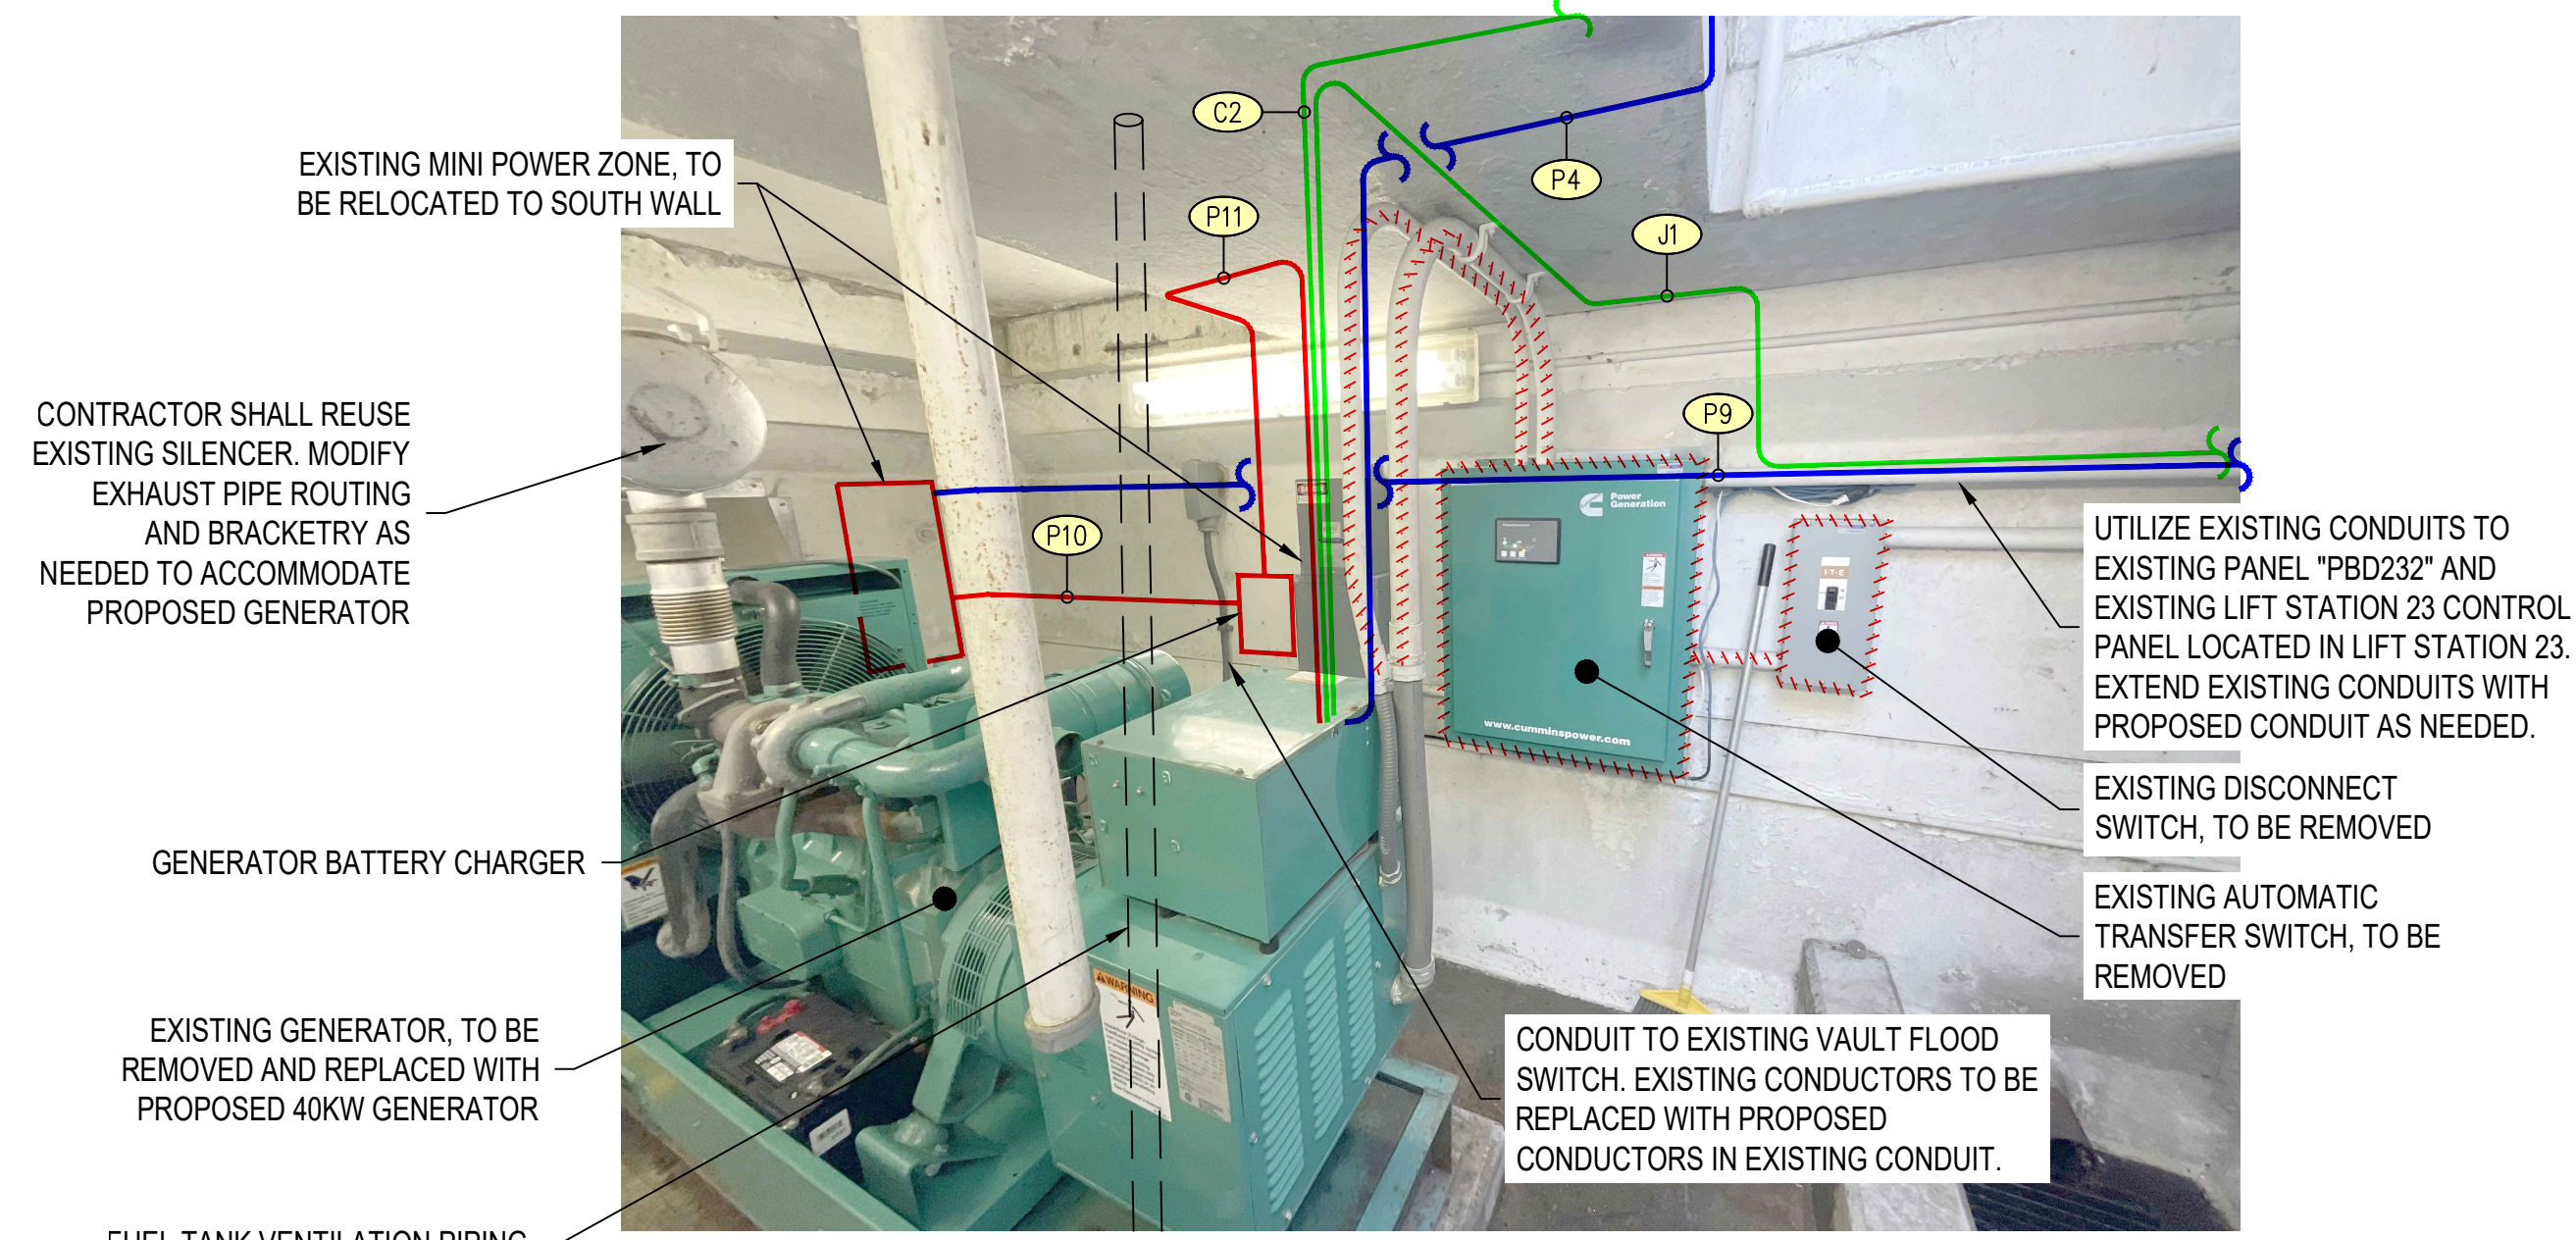


**EXISTING GENERATOR VAULT INTERIOR**  
NO SCALE

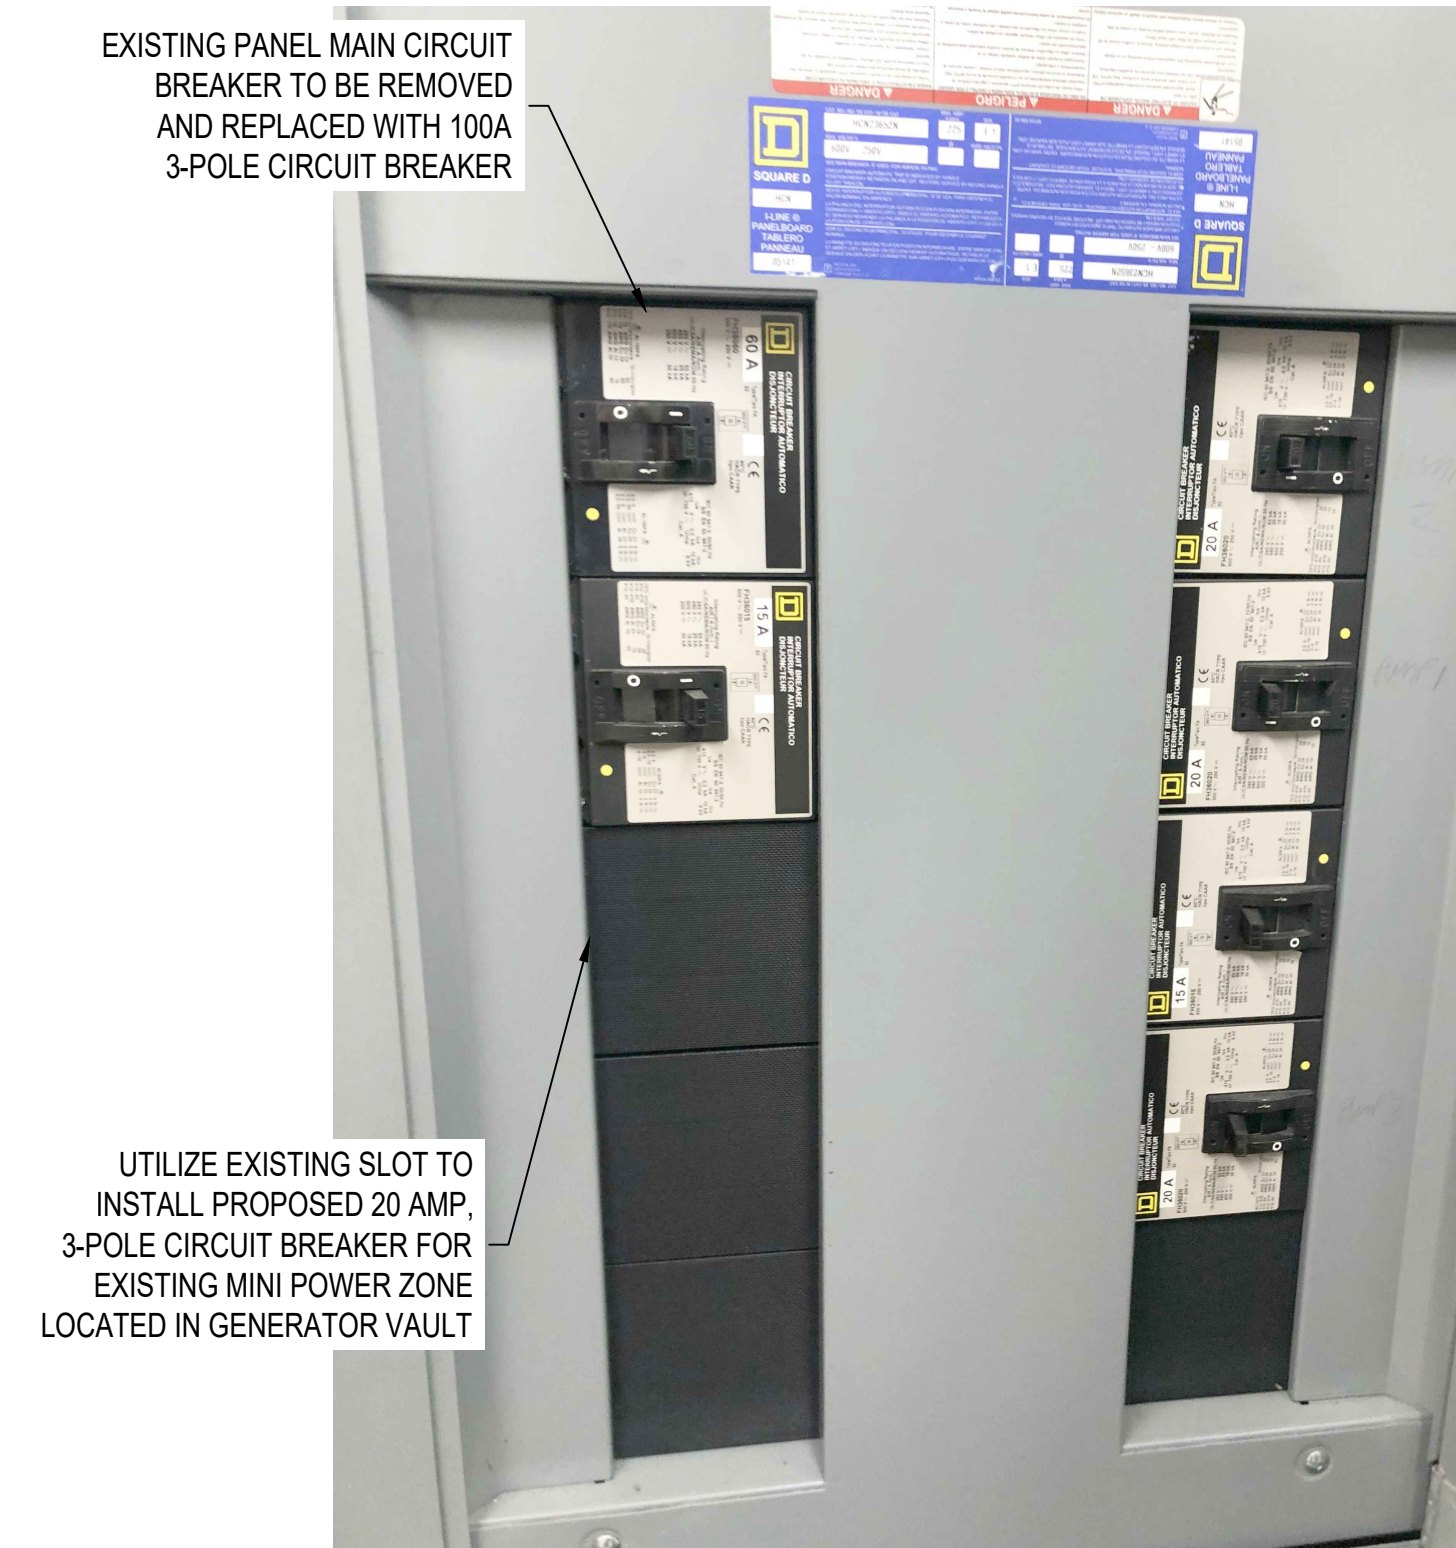

**EXISTING 480V PANEL, "PBD232"**  
NO SCALE

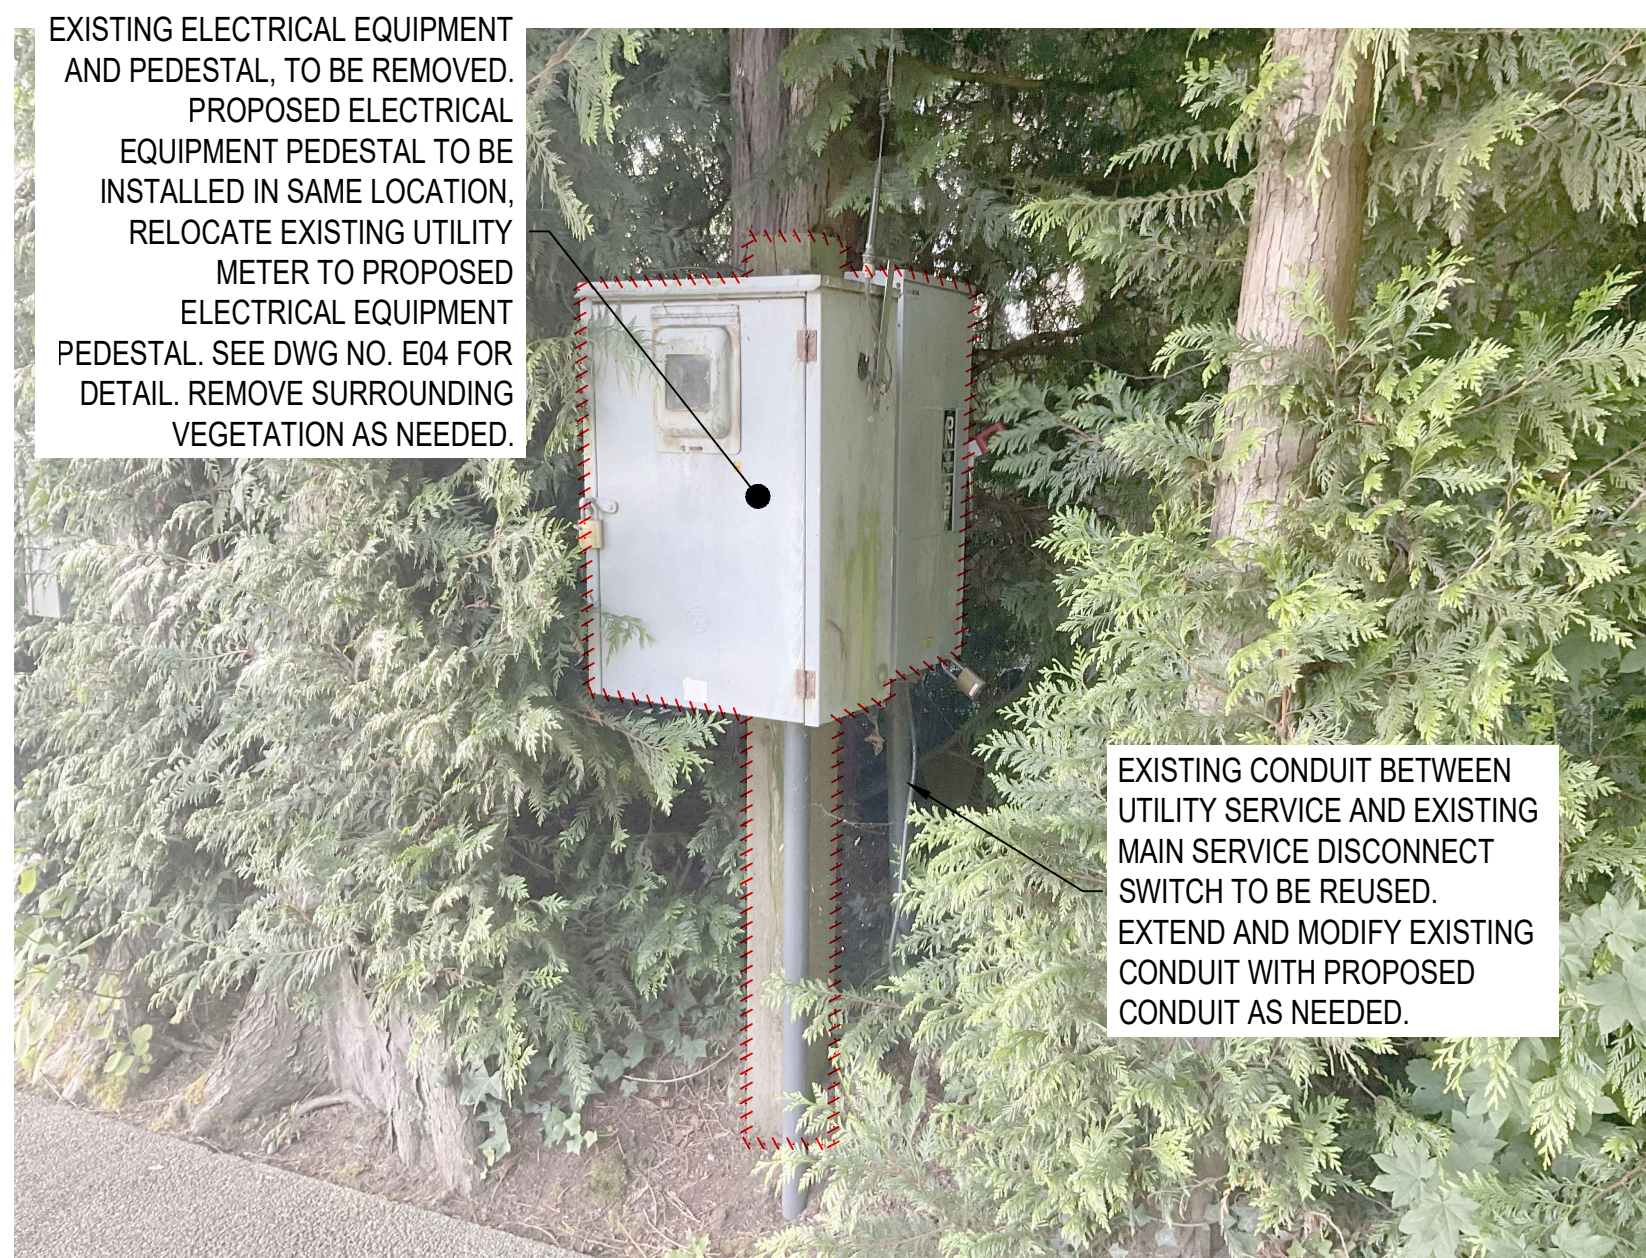

**LIFT STATION 23 EXISTING METER AND DISCONNECT PEDESTAL**  
NO SCALE

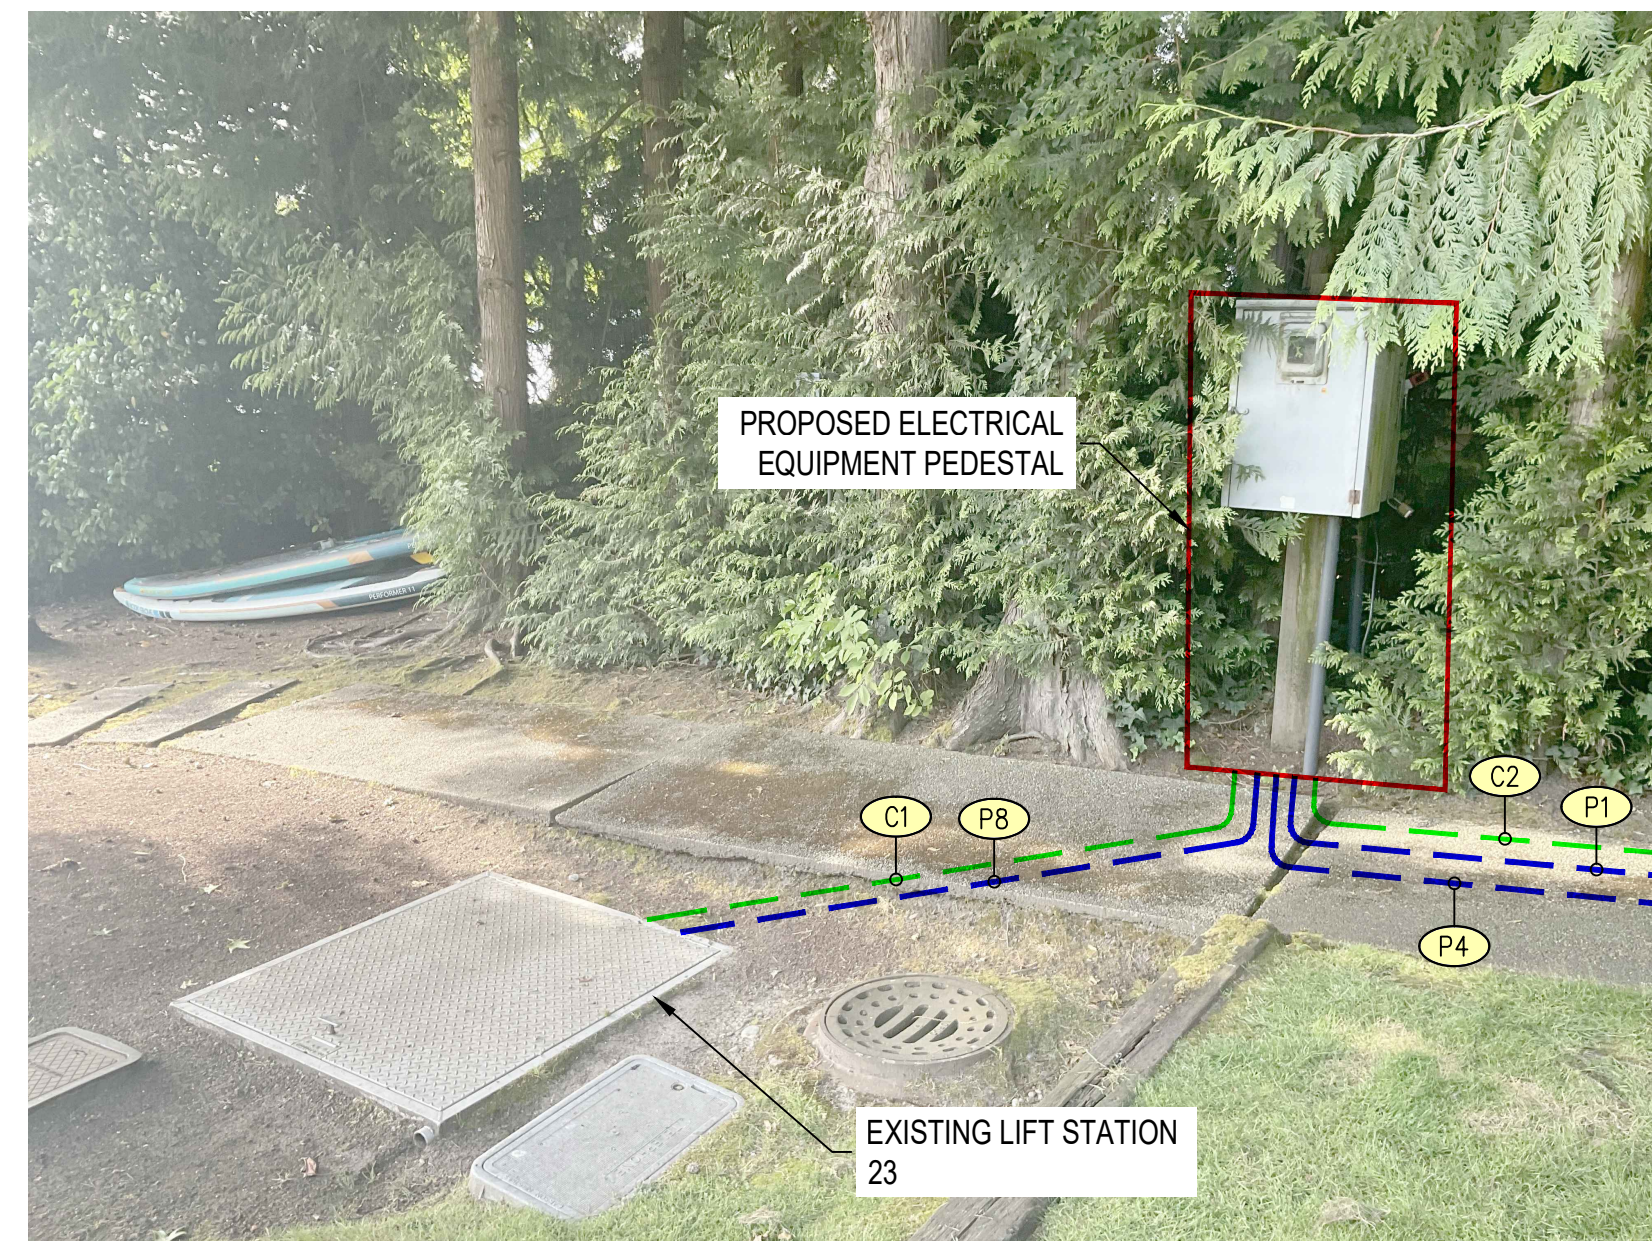

**LIFT STATION 23 SITE**  
NO SCALE



**LIFT STATION 23 SITE**  
NO SCALE


ELECTRICAL NOTES	
XX	1. SEE DWG NO. E04 FOR CONDUIT AND CONDUCTOR SCHEDULE.

REVISIONS				
NO.	DATE	DESCRIPTION	BY	REVIEW

ENGINEER: MBD	DATE: Jul 31, 2023	CLIENT: MI	JOB NO.: 210-262
REVIEWED: MWB	DATE: Aug 11, 2023	FILENAME: PSCR-D-ELEC02.DWG	
DWG NO.: E03		SHEET NO.: 3	

SCALE: SHOWN

DRAWING IS FULL SCALE WHEN BAR MEASURES 2"

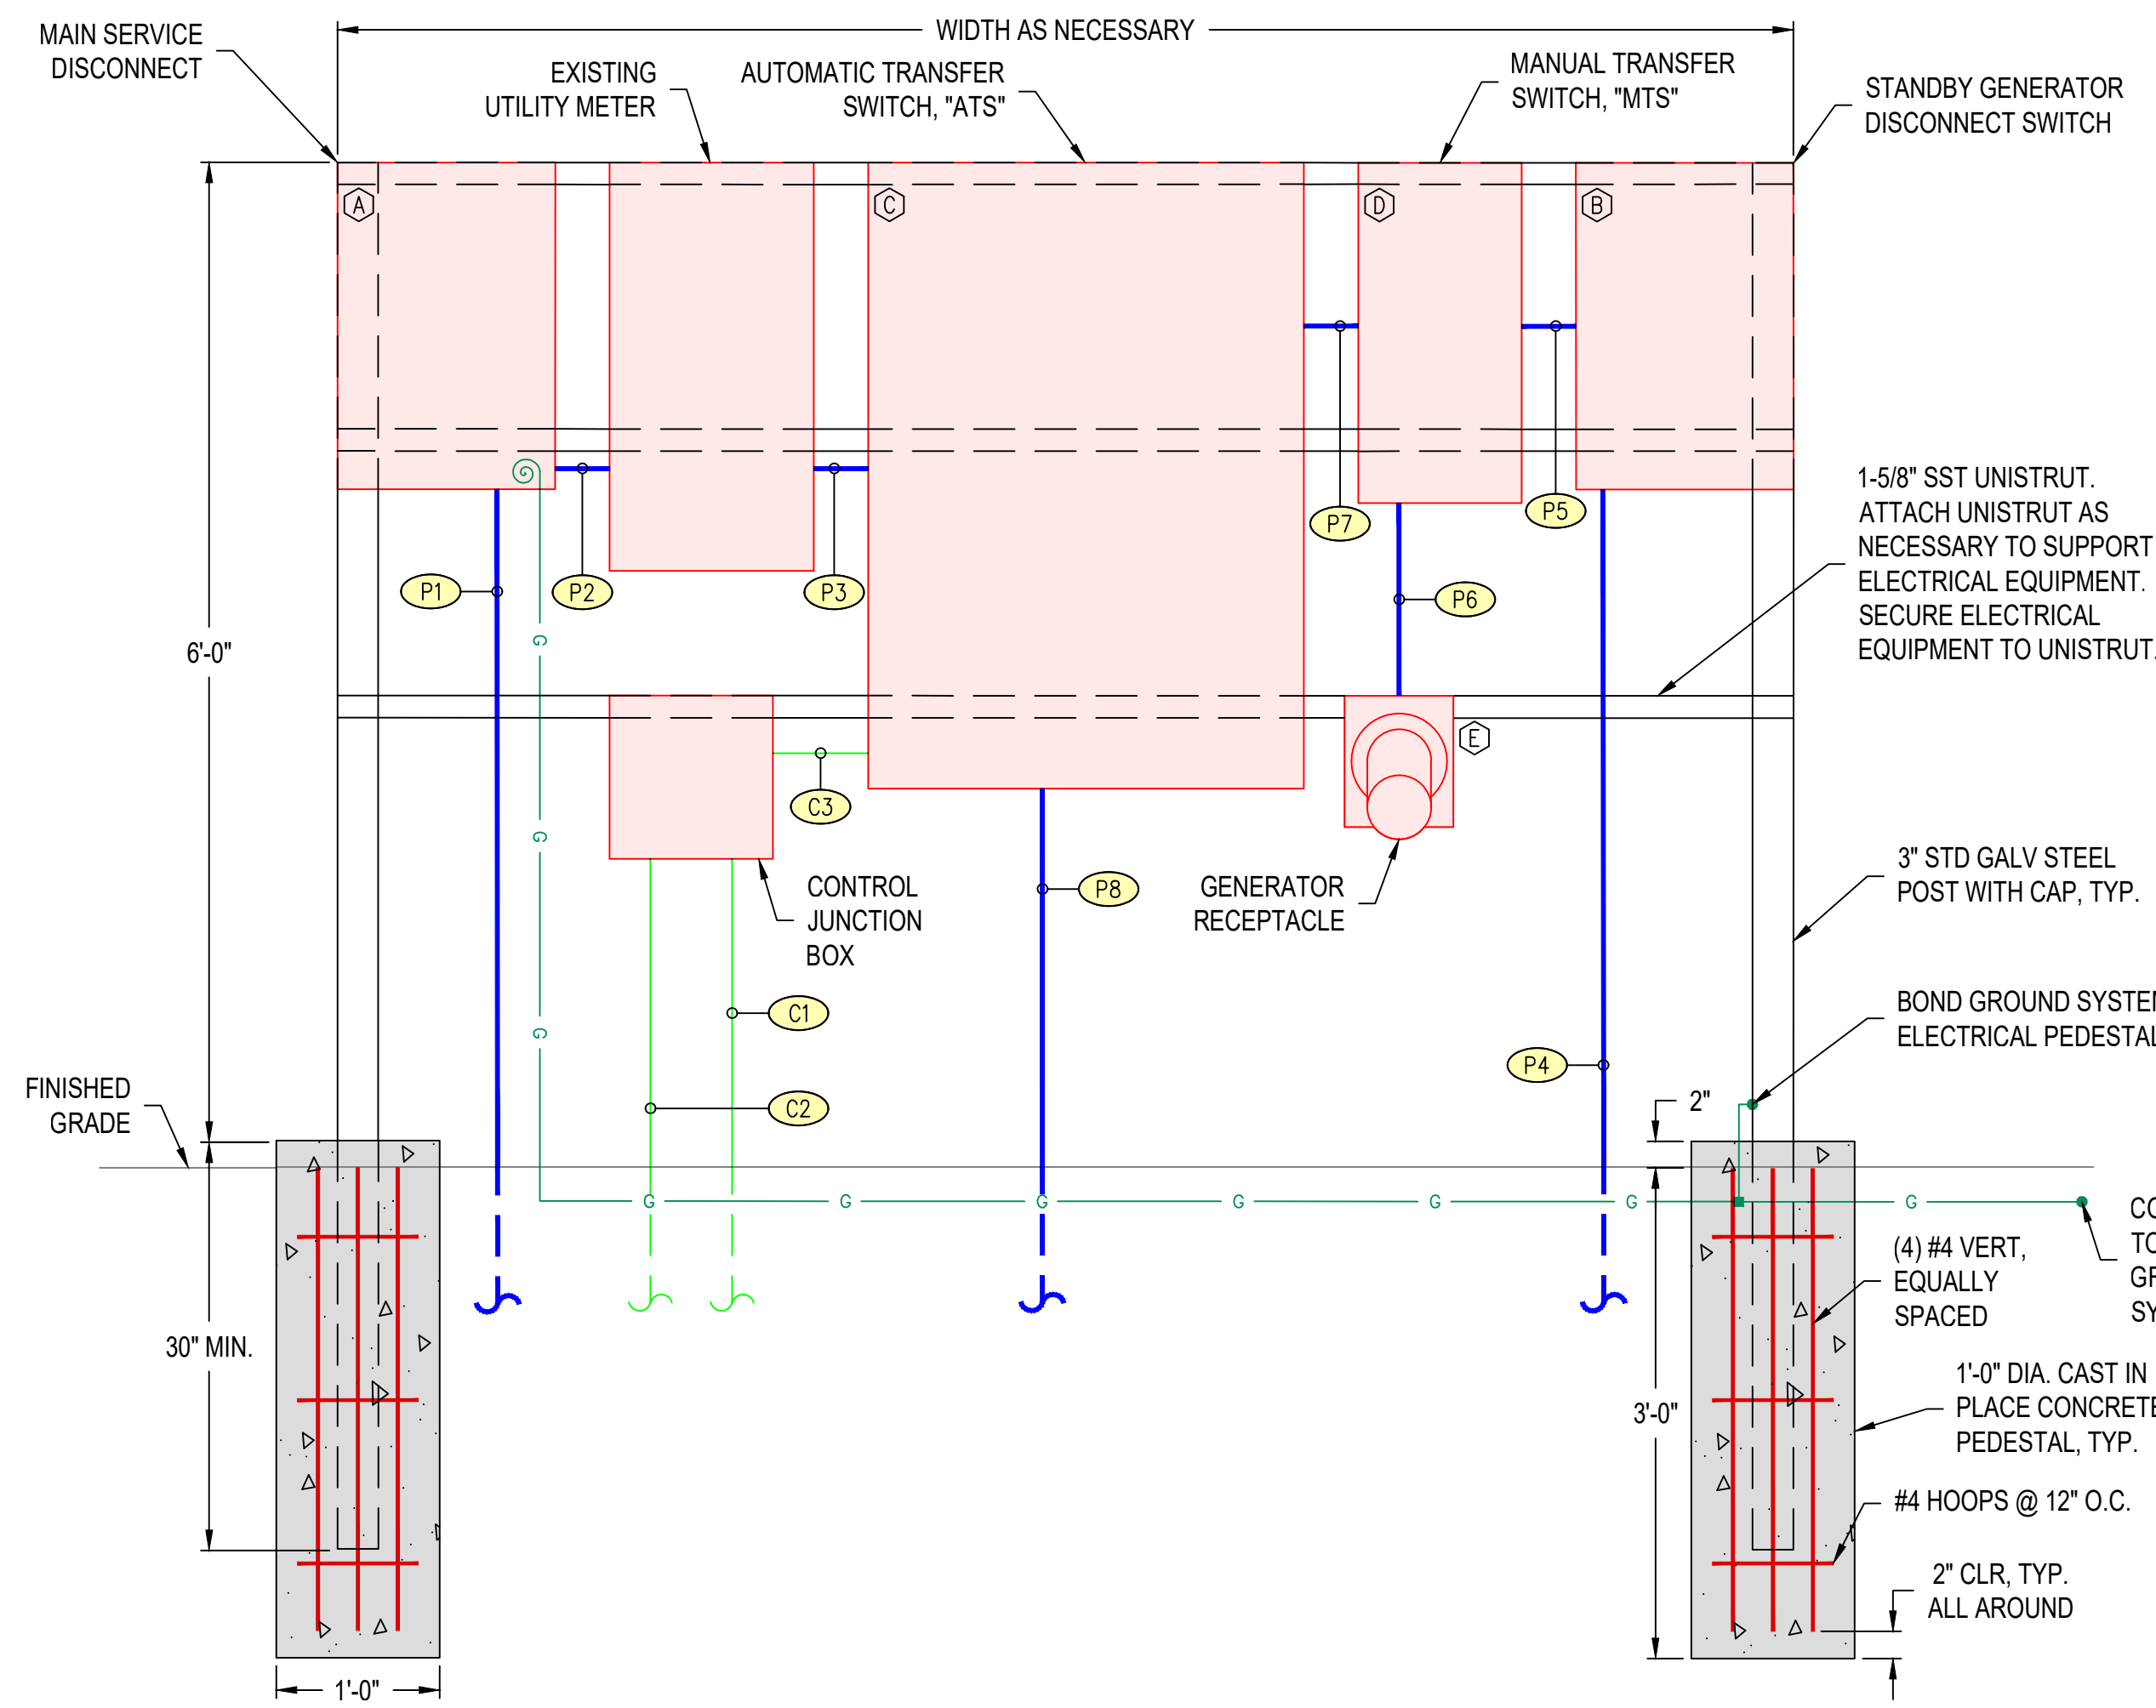

1-5/8" SST UNISTRUT. ATTACH UNISTRUT AS NECESSARY TO SUPPORT ELECTRICAL EQUIPMENT. SECURE ELECTRICAL EQUIPMENT TO UNISTRUT.


3" STD GALV STEEL POST WITH CAP, TYP.

BOND GROUND SYSTEM TO ELECTRICAL PEDESTAL

CONNECT TO EXISTING GROUNDING SYSTEM

1'-0" DIA. CAST IN PLACE CONCRETE PEDESTAL, TYP.  
#4 HOOPS @ 12" O.C.  
2" CLR, TYP. ALL AROUND

**ELECTRICAL EQUIPMENT PEDESTAL DETAIL**  
NOT TO SCALE

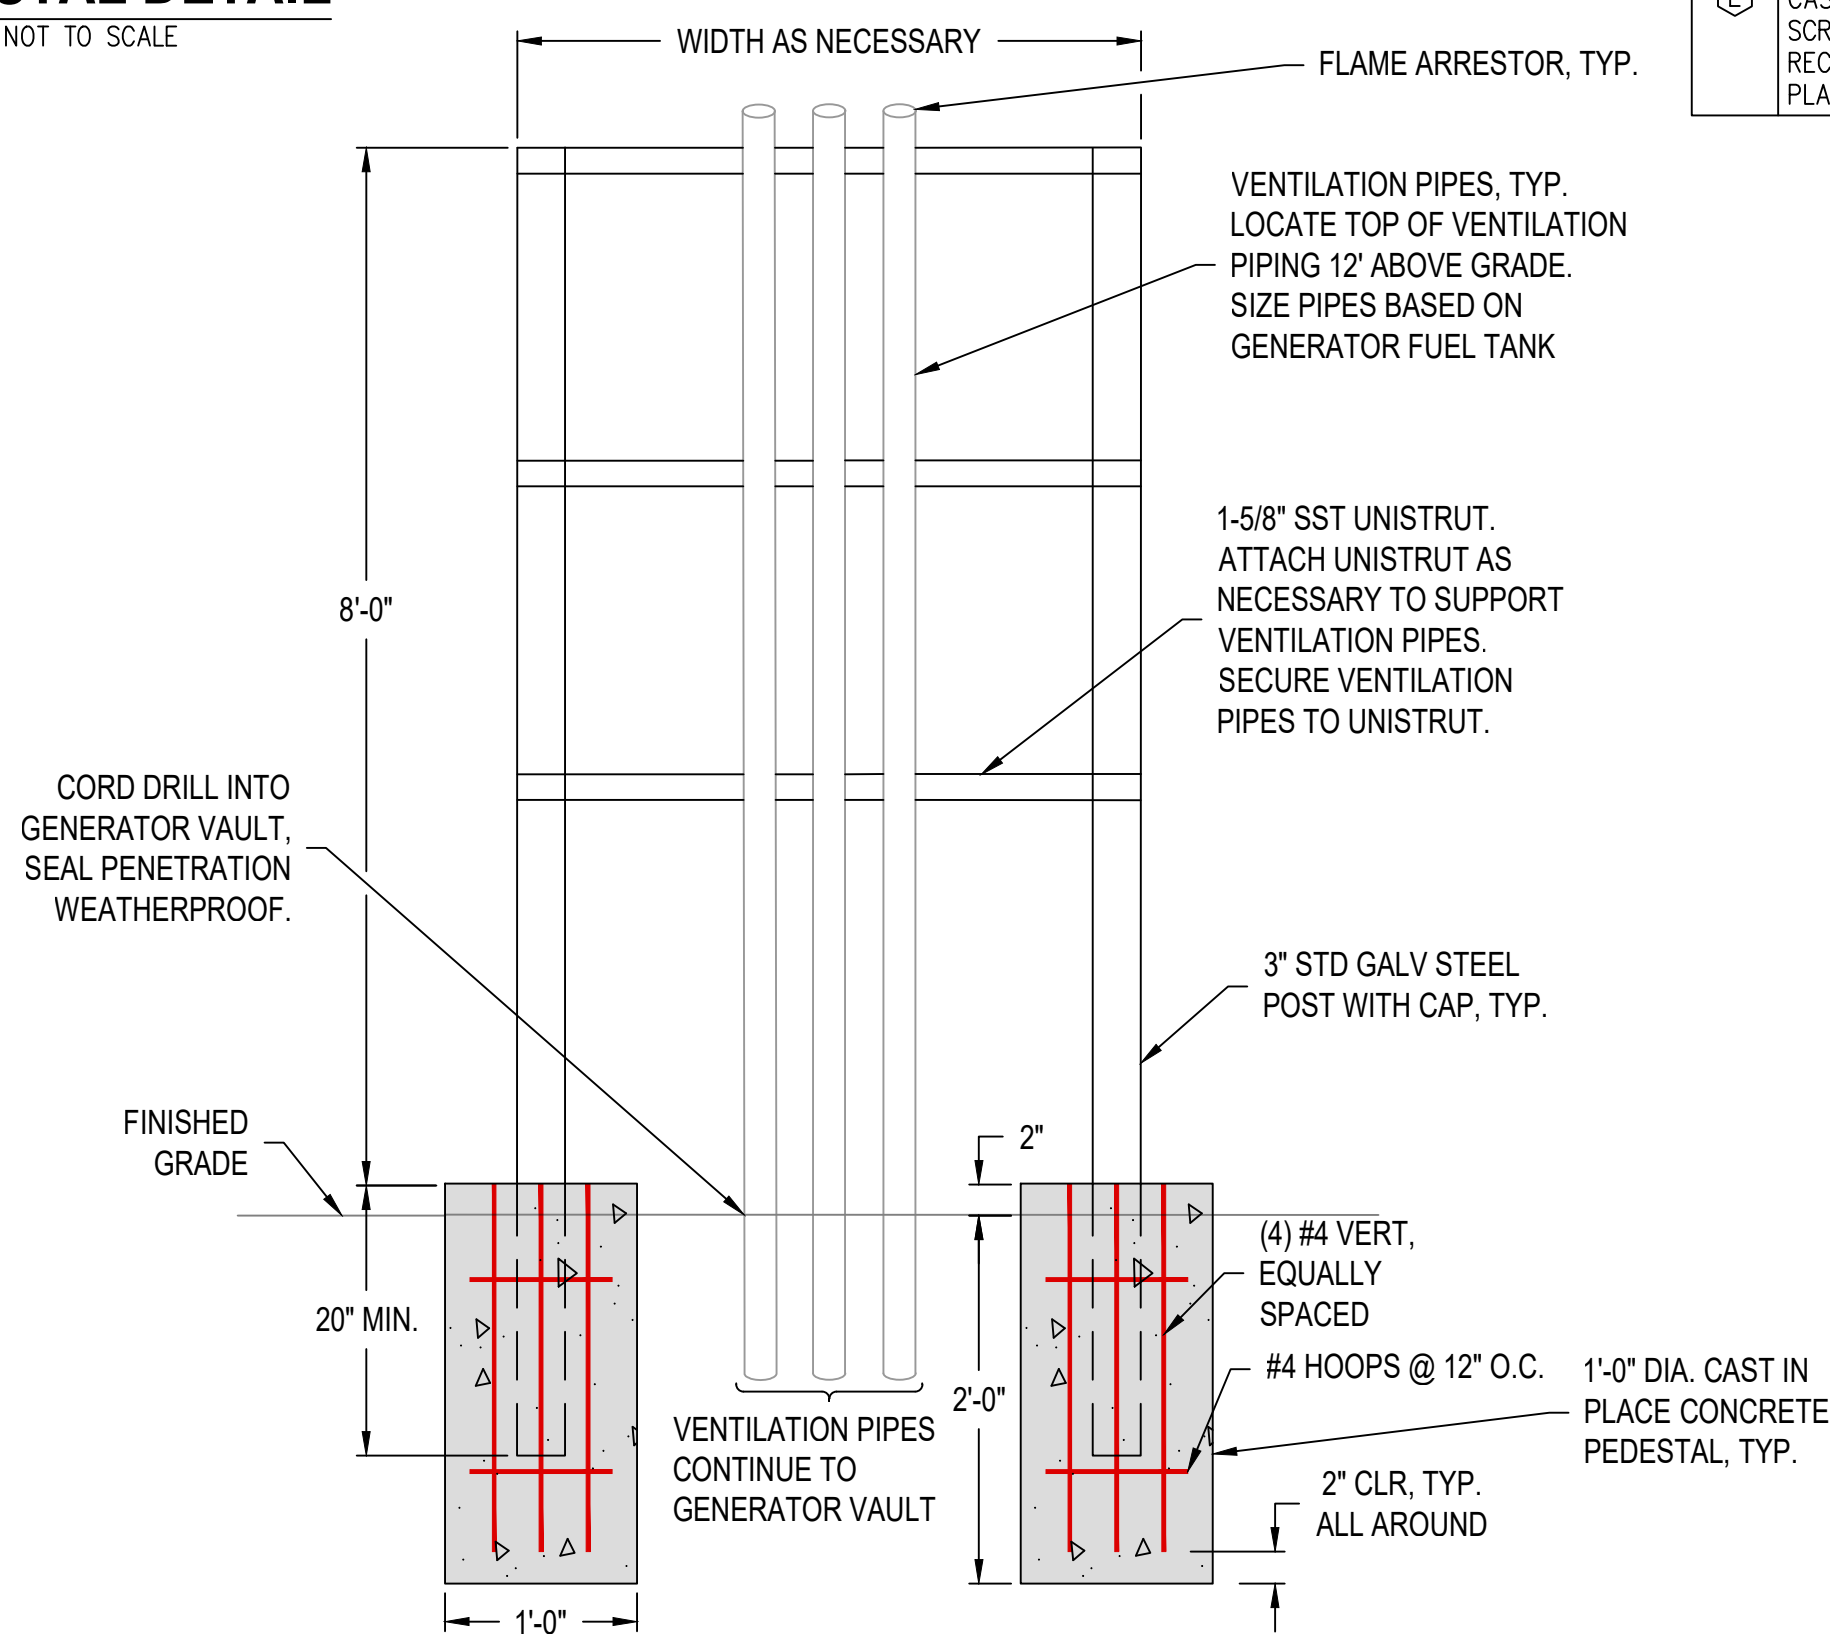

**VENTILATION PIPE SUPPORT PEDESTAL DETAIL**  
NOT TO SCALE

POWER CONDUIT AND CONDUCTOR SCHEDULE					
CIRCUIT	SOURCE	DESTINATION	TRADE SIZE	(QUANTITY) CONDUCTORS	NOTES
P1	EXISTING UTILITY SERVICE	MAIN SERVICE DISCONNECT	-	(3) - #3, (1) - #3 N	CONDUCTORS IN A COMBINATION OF EXISTING AND PROPOSED CONDUIT
P2	MAIN SERVICE DISCONNECT	EXISTING UTILITY METER	1 1/2"	(3) - #3, (1) - #3 N, (1) - #8 GRD	
P3	EXISTING UTILITY METER	AUTOMATIC TRANSFER SWITCH, "ATS"	1 1/2"	(3) - #3, (1) - #3 N, (1) - #8 GRD	
P4	STANDBY GENERATOR	STANDBY GENERATOR DISCONNECT SWITCH	1 1/2"	(3) - #3, (1) - #3 N, (1) - #8 GRD	
P5	STANDBY GENERATOR DISCONNECT SWITCH	MANUAL TRANSFER SWITCH, "MTS"	1 1/2"	(3) - #3, (1) - #3 N, (1) - #8 GRD	
P6	GENERATOR RECEPTACLE	MANUAL TRANSFER SWITCH, "MTS"	1 1/2"	(3) - #3, (1) - #3 N, (1) - #8 GRD	
P7	MANUAL TRANSFER SWITCH, "MTS"	AUTOMATIC TRANSFER SWITCH, "ATS"	1 1/2"	(3) - #3, (1) - #3 N, (1) - #8 GRD	
P8	AUTOMATIC TRANSFER SWITCH, "ATS"	EXISTING PANEL, "PBD232"	1 1/2"	(3) - #3, (1) - #3 N, (1) - #8 GRD	
P9	EXISTING PANEL, "PBD232"	EXISTING MINI POWER ZONE	-	(3) - #12, (1) - #12 GRD	CONDUCTORS IN A COMBINATION OF EXISTING AND PROPOSED CONDUIT
P10	EXISTING MINI POWER ZONE	GENERATOR BATTERY CHARGER	3/4"	(2) - #12, (1) - #12 GRD	
P11	GENERATOR BATTERY CHARGER	STANDBY GENERATOR	3/4"	(2) - #12, (1) - #12 GRD	


CONTROL CONDUIT AND CONDUCTOR SCHEDULE					
CIRCUIT	SOURCE	DESTINATION	TRADE SIZE	(QUANTITY) CONDUCTORS	NOTES
C1	EXISTING LIFT STATION 23 CONTROL PANEL	CONTROL JUNCTION BOX	3/4"	(14) - #14, (1) - #14 GRD	
C2	CONTROL JUNCTION BOX	STANDBY GENERATOR	3/4"	(11) - #14, (1) - #14 GRD	START SIGNAL FROM ATS, GENERATOR ALARMS TO LS-23 CONTROL PANEL
C3	CONTROL JUNCTION BOX	AUTOMATIC TRANSFER SWITCH, "ATS"	3/4"	(9) - #14, (1) - #14 GRD	START SIGNAL FROM ATS, ATS ALARMS TO LS-23 CONTROL PANEL

INSTRUMENTATION CONDUIT AND CONDUCTOR SCHEDULE					
CIRCUIT	SOURCE	DESTINATION	TRADE SIZE	(QUANTITY) CONDUCTORS	NOTES
J1	STANDBY GENERATOR	EXISTING LIFT STATION 23 CONTROL PANEL	-	(1) 2-CONDUCTOR SHIELDED CABLE	CONDUCTORS IN A COMBINATION OF EXISTING AND PROPOSED CONDUIT

ELECTRICAL EQUIPMENT AND INSTRUMENTATION SCHEDULE				
ITEM	DESCRIPTION	MANUFACTURER	MODEL NO.	
A	MAIN SERVICE DISCONNECT SWITCH - NEMA 4X SS ENCLOSURE, HEAVY DUTY BREAKER, SERVICE ENTRANCE RATED, ELECTRONIC TRIP, 100 AMP, 480 VOLT, 3φ 42 KAIC WITHSTAND, CIRCUIT BREAKER SWITCH.	SIEMENS	SHJ06 OR EQUAL	
B	GENERATOR DISCONNECT SWITCH - NEMA 4X SS ENCLOSURE, HEAVY DUTY BREAKER, ELECTRONIC TRIP, 100 AMP, 480 VOLT, 3φ 42 KAIC WITHSTAND, CIRCUIT BREAKER SWITCH. FLEX HANDLE OPERATOR MOUNTED ON SIDE OF ENCLOSURE.	SIEMENS	SHJ06 OR EQUAL	
C	AUTOMATIC TRANSFER SWITCH - NEMA 4X SS ENCLOSURE, 100 AMP, 480 VOLT, 3 PHASE, 3 POLE, 42 KAIC WITHSTAND.	SEE SPECIFICATIONS	SEE SPECIFICATIONS	
D	MANUAL TRANSFER SWITCH - 100 AMP, 3-PHASE, 600 VOLT, HEAVY DUTY DOUBLE THROW NON-FUSIBLE SAFETY SWITCH, NEMA 4X SS ENCLOSURE	SIEMENS	DTNF363S OR EQUAL	
E	GENERATOR RECEPTACLE - 480 VOLT, 3-PHASE, 4 WIRE SERVICE. 100 AMP WITH LARGE WIRE RECESS AND REVERSED CONTACTS (FEMALE). RECEPTACLE SHALL BE PROVIDED WITH CAST BACK BOX, ANGLE ADAPTER, GASKETS, ADNA GASKETED SCREW-TYPE, WEATHERTIGHT CAP WITH CHAIN FASTENER. RECEPTACLE SHALL ACCOMMODATE CONDUCTOR SIZE SHOWN ON PLANS.	CROUSE-HINDS	ARKTITE AREA10426-S22	


PROPOSED DISCRETE INPUTS			
EXISTING DIGITAL INPUT CARD			
SLOT	CHANNEL	NAME	
5	4	GENERATOR RUN STATUS	
5	5	GENERATOR FAULT	
5	6	GENERATOR LOW FUEL ALARM	
5	7	GENERATOR PRE-ALARM WARNING	
5	8	ATS IN NORMAL	
5	9	ATS IN GENERATOR	
5	10	ATS UTILITY POWER AVAILABLE	
5	11	GENERATOR VAULT FLOOD SWITCH ALARM	

PROPOSED ANALOG INPUTS			
EXISTING ANALOG INPUT CARD			
SLOT	CHANNEL	NAME	
11	1	GENERATOR FUEL LEVEL	

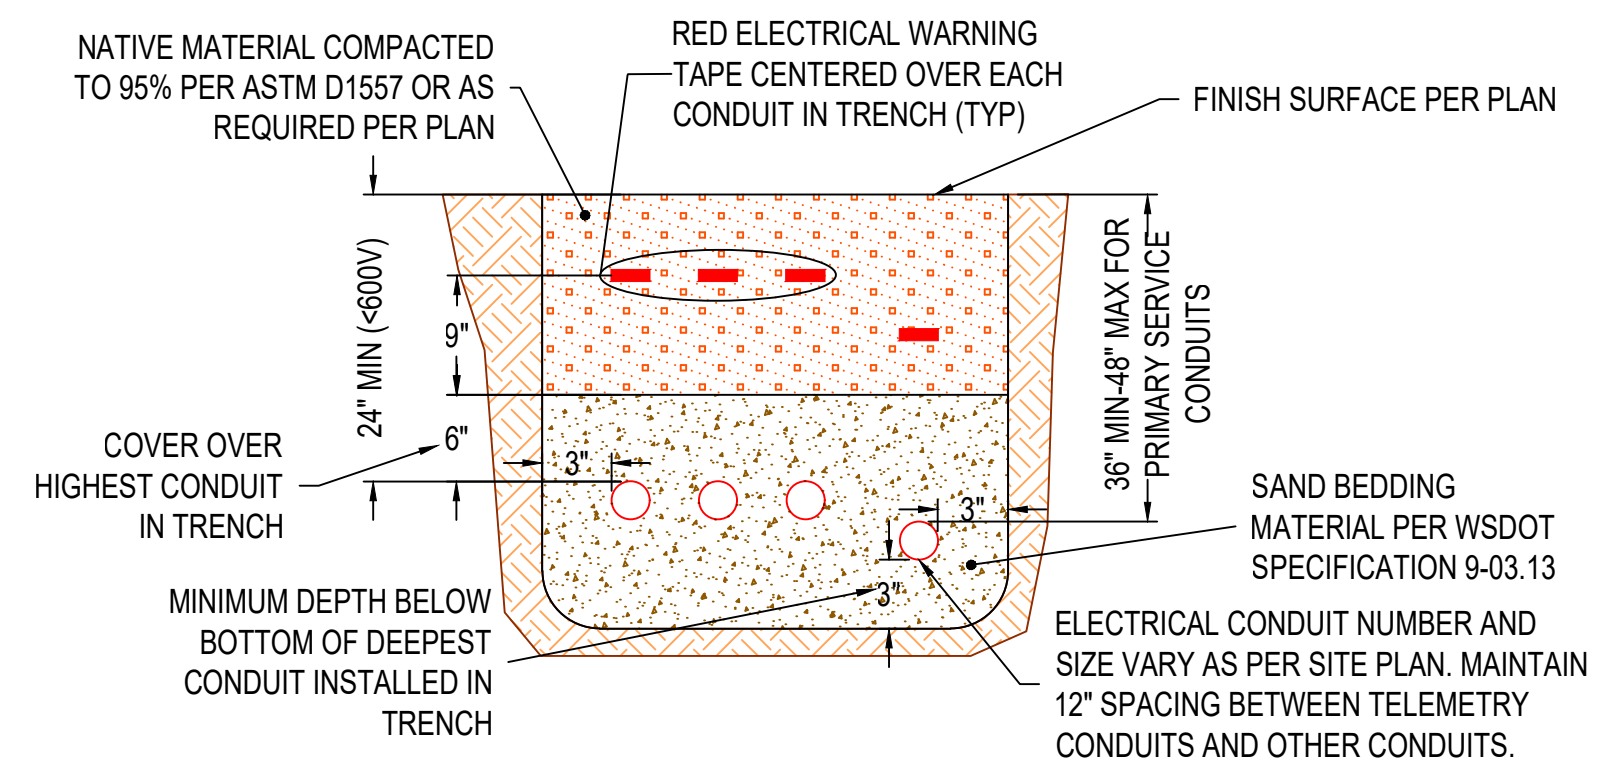

**TYPICAL ELECTRICAL TRENCH DETAIL**  
NOT TO SCALE


NOTE: BURY DEPTH OF CONDUIT AND HORIZONTAL SPACING SHALL BE CONFIRMED WITH SERVING UTILITY BEFORE CONSTRUCTION.

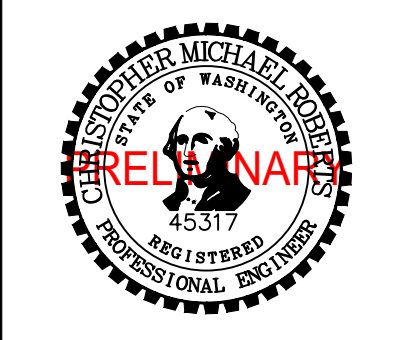

**CITY OF MERCER ISLAND**  
**SEWER PUMP STATION GENERATOR REPLACEMENT**  
**LS 23 ELECTRICAL DETAILS, SCHEDULES AND TELEMETRY MODIFICATIONS**

NO.	DATE	DESCRIPTION	BY	REVIEW

P:\H:\C:\USERS\JACKSON\BPC\DWG\1820948 FILENAME: I23701.DWG PLOT DATE: 5/11/2022 2:38 PM CAD USER: DAN JACKSON

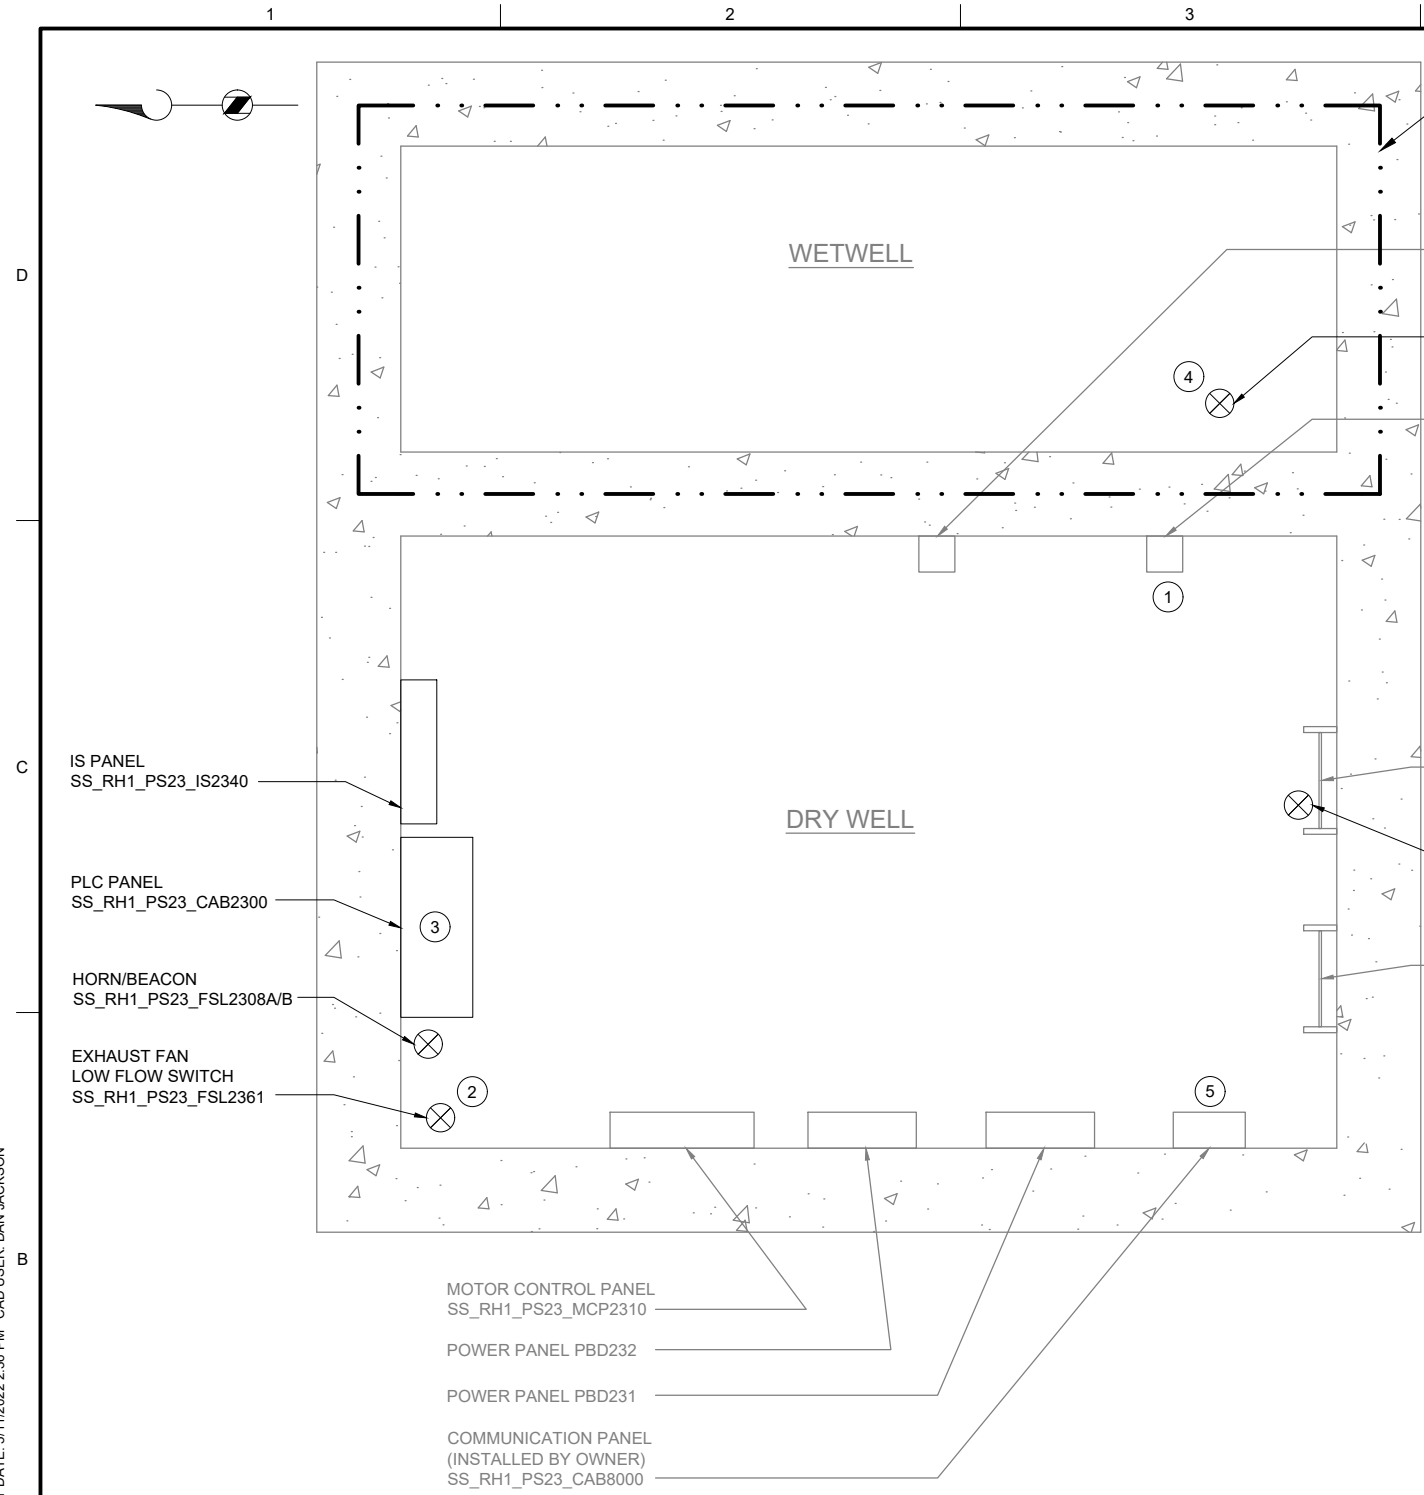

PLAN  
SCALE: 3/4" = 1'-0"

CIRCUIT & RACEWAY SCHEDULE							
CIRCUIT	FUNCTION	WIRE SIZE & PHASE ASSIGNMENT	FROM	TO	RACEWAY SIZE	DESCRIPTION	LOCATION(S)
C-2301	CONTROL	14-#14	SS_RH1_PS23_CAB2300	SS_RH1_PS23_IS2340	3/4"	LEVEL SWITCHES, FAULT, PANEL MONITORING, SPARES	GRATING LEVEL
C-2302	CONTROL	6-#14	SS_RH1_PS23_IS2340	SS_RH1_PS23_MCP2310	3/4"	CALL PUMPS TO RUN	GRATING LEVEL
C-2303	CONTROL	2-#14	SS_RH1_PS23_CAB2300	SS_RH1_PS23_FSL2361	3/4"	EXHAUST FAN FLOW SWITCH	GRATING LEVEL
C-2304	CONTROL	4-#14, #14G	SS_RH1_PS23_CAB2300	SS_RH1_PS23_YA2308A/B	3/4"	HORN/RED BEACON FAN ALARM	GRATING LEVEL
P/C-2305	POWER/CONTROL	10-#14, #14G CORD	SS_RH1_PS23_CAB2300	SS_RH1_PS23_GNG2300	-	POWER AND CONTROL TO GNG PANEL	GRATING LEVEL TO STATION HATCH DOOR
P-2301	POWER	2#14, #14G	SS_RH1_PS23_CAB2300	SS_RH1_PS23_IS2340	3/4"	24VDC POWER TO IS PANEL MODULE	GRATING LEVEL
P-2302	POWER	2#12, #12G	PBD231	SS_RH1_PS23_IS2340	3/4"	120VAC POWER TO IS PANEL POWER SUPPLY	GRATING LEVEL
P-2304	POWER	2#14, #14G	SS_RH1_PS23_CAB2300	SS_RH1_PS23_FSL2361	3/4"	POWER TO THERMAL FLOW SWITCH	GRATING LEVEL
S-2301	SIGNAL	2 TSP	SS_RH1_PS23_CAB2300	SS_RH1_PS23_IS2340	3/4"	2 LIT READINGS	GRATING LEVEL
S-2302	SIGNAL	MFR CABLE	SS_RH1_PS23_JB2341	SS_RH1_PS23_IS2340	3/4"	PRIMARY WETWELL LEVEL. *NEW CONDUIT FROM JB TO IS PANEL	GRATING LEVEL
S-2303	SIGNAL	MFR CABLE	SS_RH1_PS23_LE2342	SS_RH1_PS23_IS2340	3/4"	SECONDARY WETWELL LEVEL. *NEW CONDUIT IN DRY WELL	GRATING LEVEL

**GENERAL NOTES:**


1. PLAN DRAWING IS PARTIAL REPRESENTATION OF THE SITE AND IS ONLY INTENDED TO PROVIDE DETAILS RELATED TO THE SCOPE OF THIS WORK.
2. REFERENCE AS-BUILT RECORD DRAWING BY CAREY & KRAMER CONSULTING ENGINEERS, DRAWING NUMBER 6223-M317.2, SHEET 18 OF 32 FOR ELEVATIONS RELATED TO WIRING AND CONDUIT.
3. REFER TO CIRCUIT & RACEWAY SCHEDULE ON THIS DRAWING FOR NEW WIRING AND CONDUIT WITHIN THE PUMP STATION.

**KEY NOTES:**

- 1 REFER TO SECTION 26 05 00 FOR CONDUIT SEAL OFF REQUIREMENTS FROM CLASS I DIV 1 WETWELL.
- 2 REFER TO DWG I-00004 DETAIL C FOR THERMAL FLOW SWITCH INSTALLATION DETAIL ON EXISTING EXHAUST DUCT.
- 3 REFER TO SECTION 26 05 00 FOR PLACING COMPRESSION FITTINGS ON EXISTING CONDUIT TO ROUTE TO NEW PANEL.
- 4 COORDINATE WITH OWNER ON FOGROD INSTALLATION LOCATION IN WETWELL.
- 5 LOCATION OF COMMUNICATION PANEL IS APPROXIMATE. COORDINATE WITH OWNER ON FINAL COMMUNICATION PANEL LOCATION.



**BID SET**

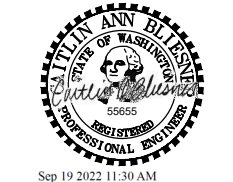

**CITY OF MERCER ISLAND  
SEWER SCADA SYSTEMS REPLACEMENT**

REVISIONS		
REV	DATE	DESCRIPTION

LINE IS 2 INCHES AT FULL SIZE  
DESIGNED: CAB  
DRAWN: DNW  
CHECKED: LSL  
CHECKED: LSL  
APPROVED: CAB

FILENAME: I-23701.DWG  
BC PROJECT NUMBER: 153585  
CLIENT PROJECT NUMBER

**INSTRUMENTATION  
PUMP STATION 23 - PLAN**

DRAWING NUMBER  
**I-23701**  
SHEET NUMBER  
375 OF 424